

N.T.S. DUCT BANK SECTION - 1 CIRCUITS (345kV) B TREFOIL CONFIGURATION - HORIZONTAL

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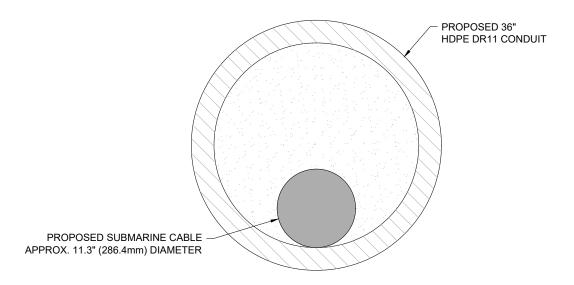
1400 Broadway, 21st Floor New York, NY 10018-0000 Certificate of Authorization #: 0017019


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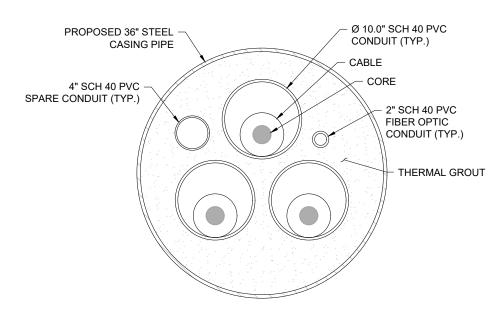
Client EMPIRE OFFSHORE WIND LLC.

	E	05/30/2023	JSR	RE-ISSUED FOR ARTICLE VII APP. (2 CIRCUIT)	KEK	MDN
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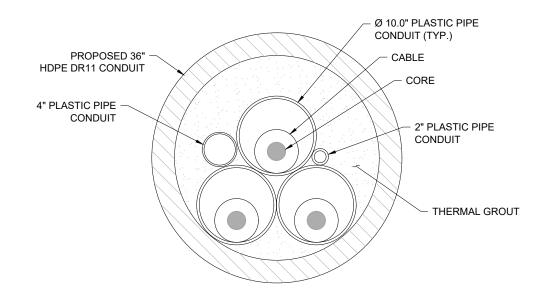
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N.T.S. AUGER BORE SECTION FOR INTERCONNECTION CABLES (E) 1 CIRCUIT



N.T.S. HDD SECTION FOR ONSHORE EXPORT CABLES D 1 CIRCUIT

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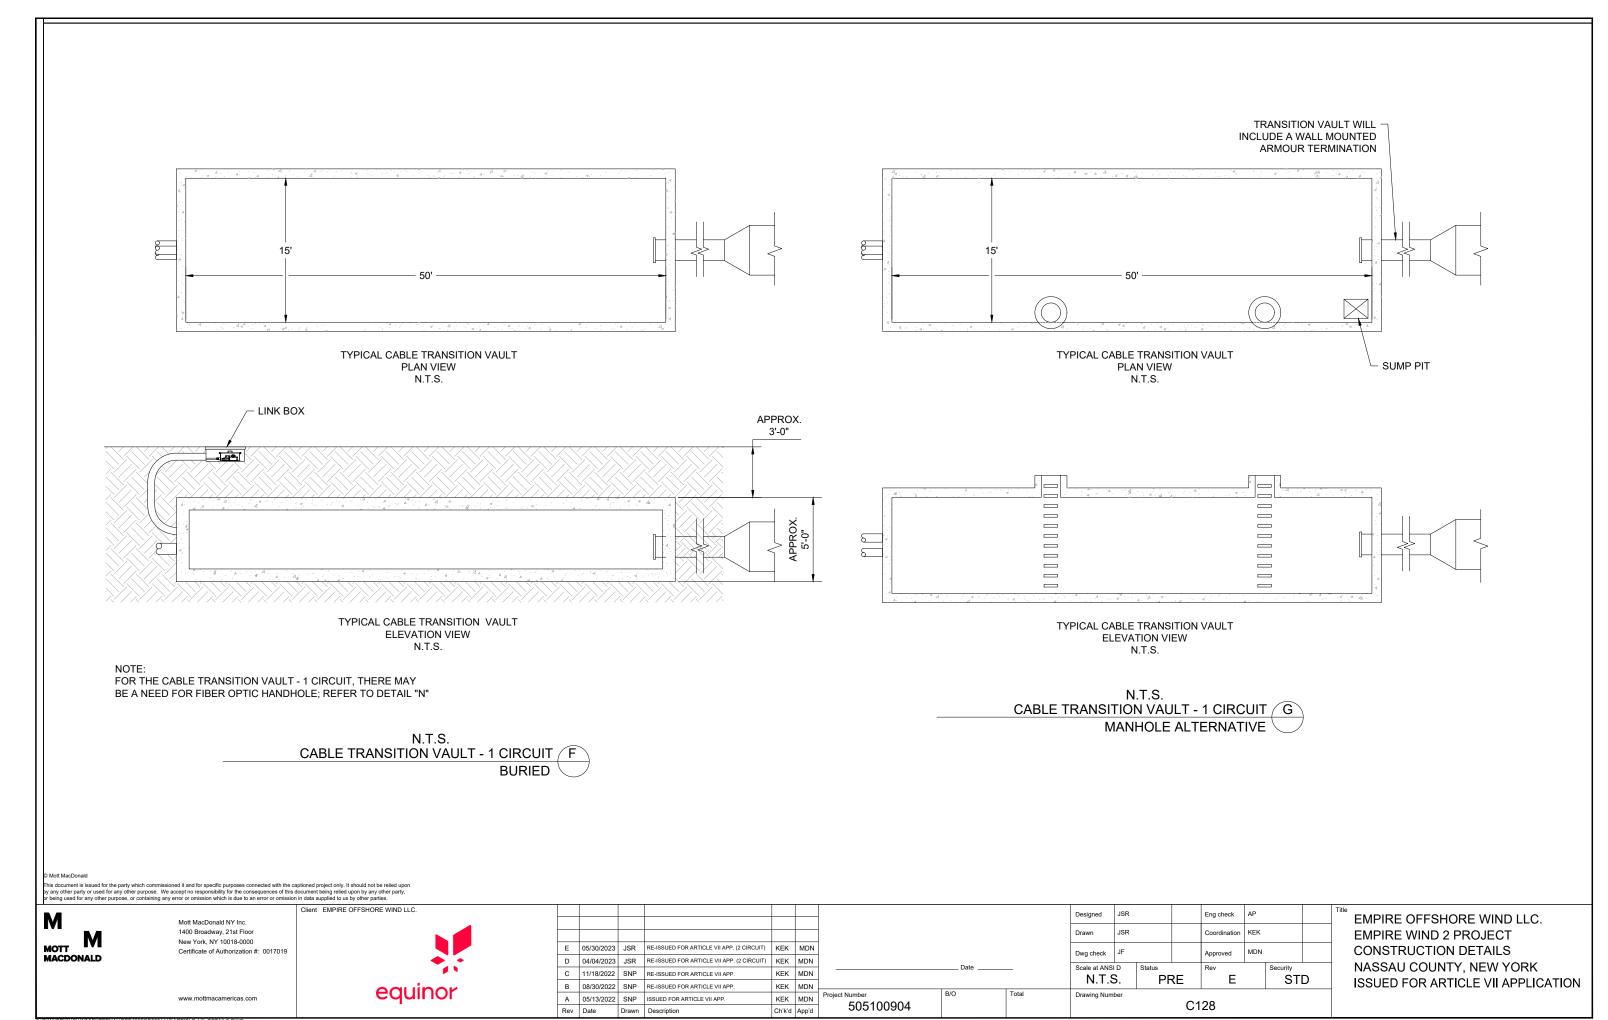
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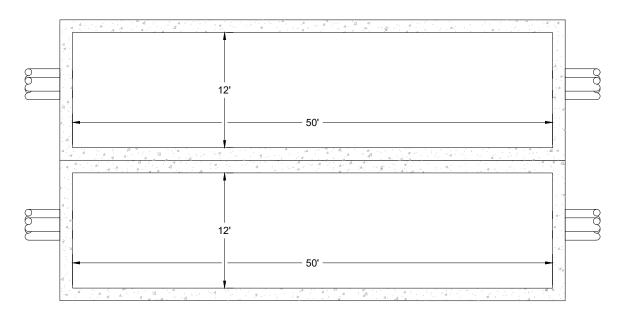
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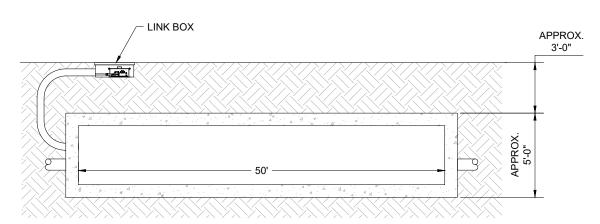
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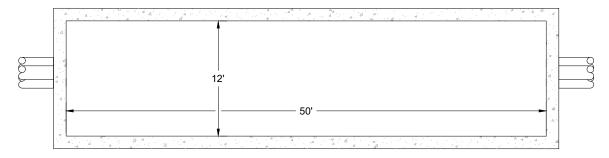
TYPICAL CABLE SPLICING VAULT PLAN VIEW N.T.S.

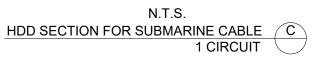


TYPICAL CABLE SPLICING VAULT **ELEVATION VIEW** N.T.S.

FOR THE JOINT BAY / SPLICE VAULT - 2 CIRCUIT, THERE MAY BE A NEED FOR FIBER OPTIC HANDHOLE; REFER TO DETAIL "N"

> N.T.S. JOINT BAY / SPLICE VAULT - 2 CIRCUIT / H **BURIED**



TYPICAL CABLE SPLICING VAULT PLAN VIEW N.T.S.

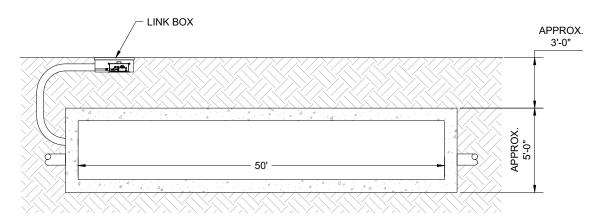

TYPICAL CABLE SPLICING VAULT **ELEVATION VIEW** N.T.S.

FOR THE JOINT BAY / SPLICE VAULT - 1 CIRCUIT, THERE MAY BE A NEED FOR FIBER OPTIC HANDHOLE; REFER TO DETAIL "N"

> N.T.S. JOINT BAY / SPLICE VAULT - 1 CIRCUIT ( ) **BURIED**

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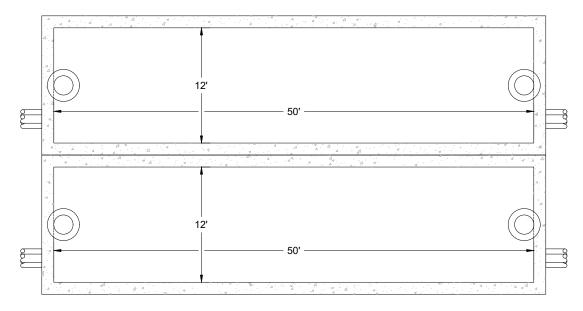
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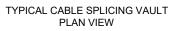
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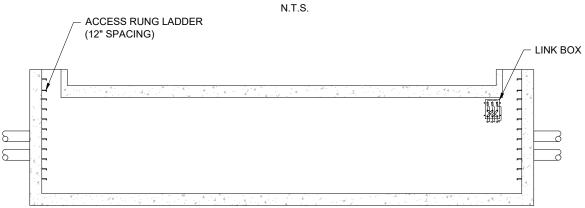
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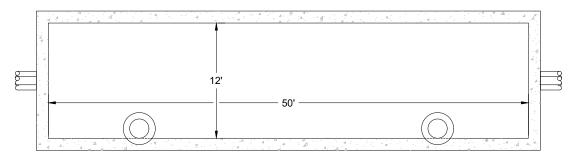



TYPICAL CABLE SPLICING VAULT ELEVATION VIEW N.T.S.

N.T.S.

JOINT BAY / SPLICE VAULT - 2 CIRCUIT

MANHOLE ALTERNATIVE



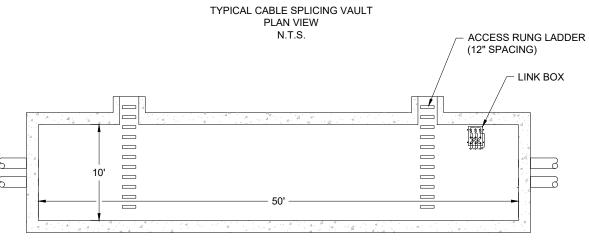

TYPICAL CABLE SPLICING VAULT ELEVATION VIEW N.T.S.

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JOINT BAY / SPLICE VAULT - 1 CIRCUIT K

MANHOLE ALTERNATIVE

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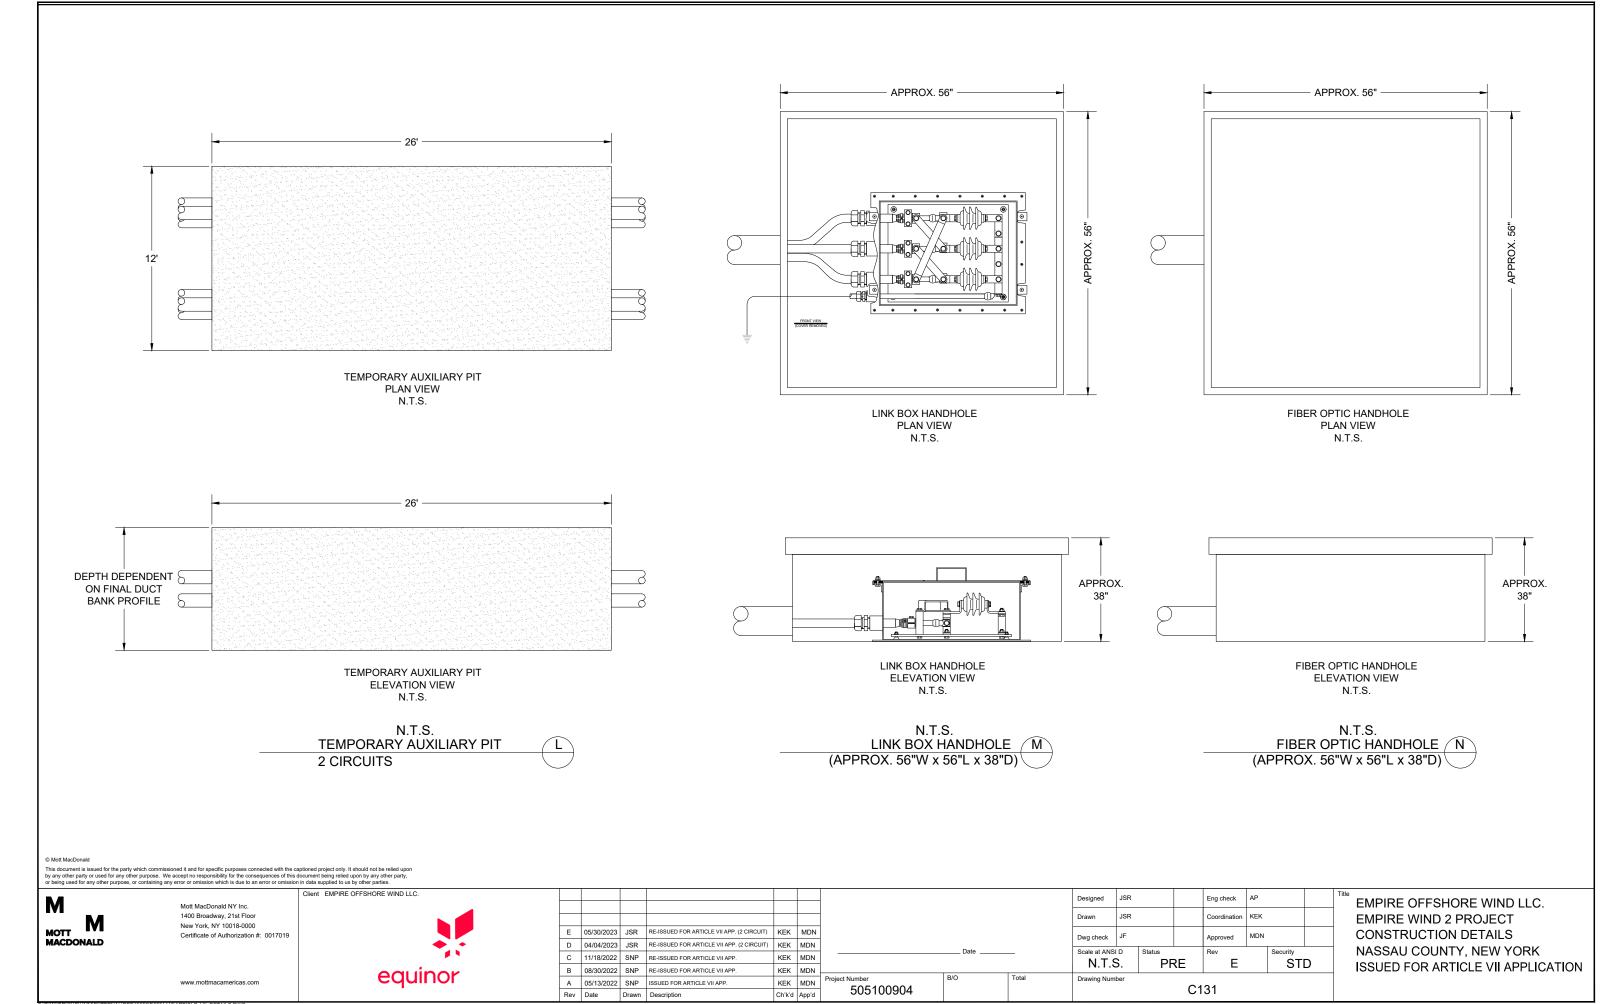
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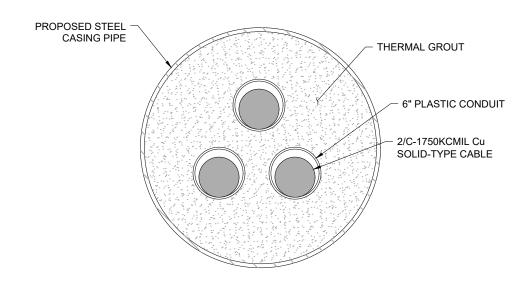
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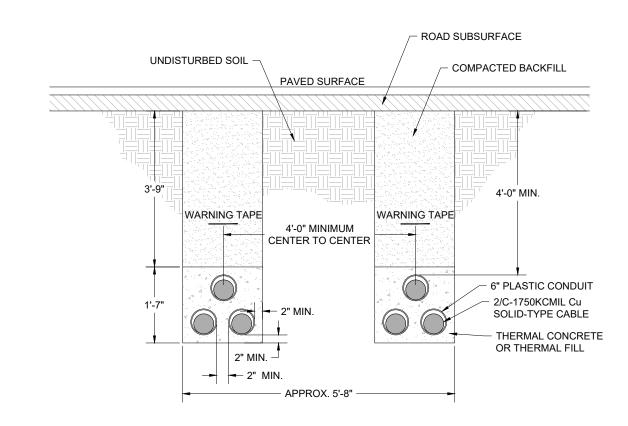
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N.T.S. AUGER BORE SECTION - 1 CIRCUIT (138kV) SYSTEM INTERCONNECTION CABLES



N.T.S. DUCT BANK SECTION - 2 CIRCUITS (138kV) P SYSTEM INTERCONNECTION CABLES

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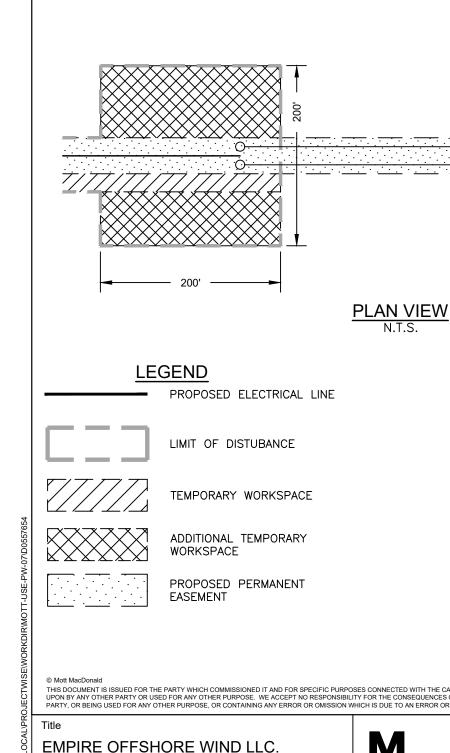
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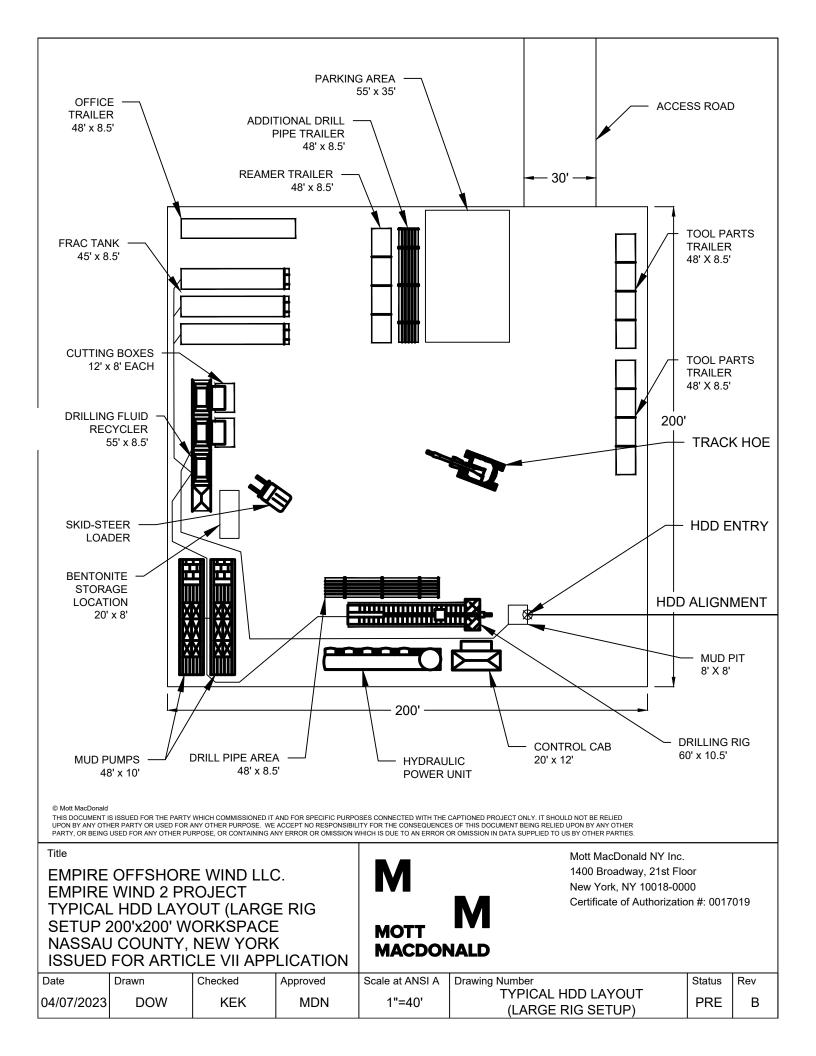
**EMPIRE WIND 2 PROJECT** TYPICAL HDD WORKSPACE SKETCH NASSAU COUNTY, NEW YORK ISSUED FOR ARTICLE VII APPLICATION


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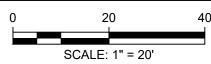
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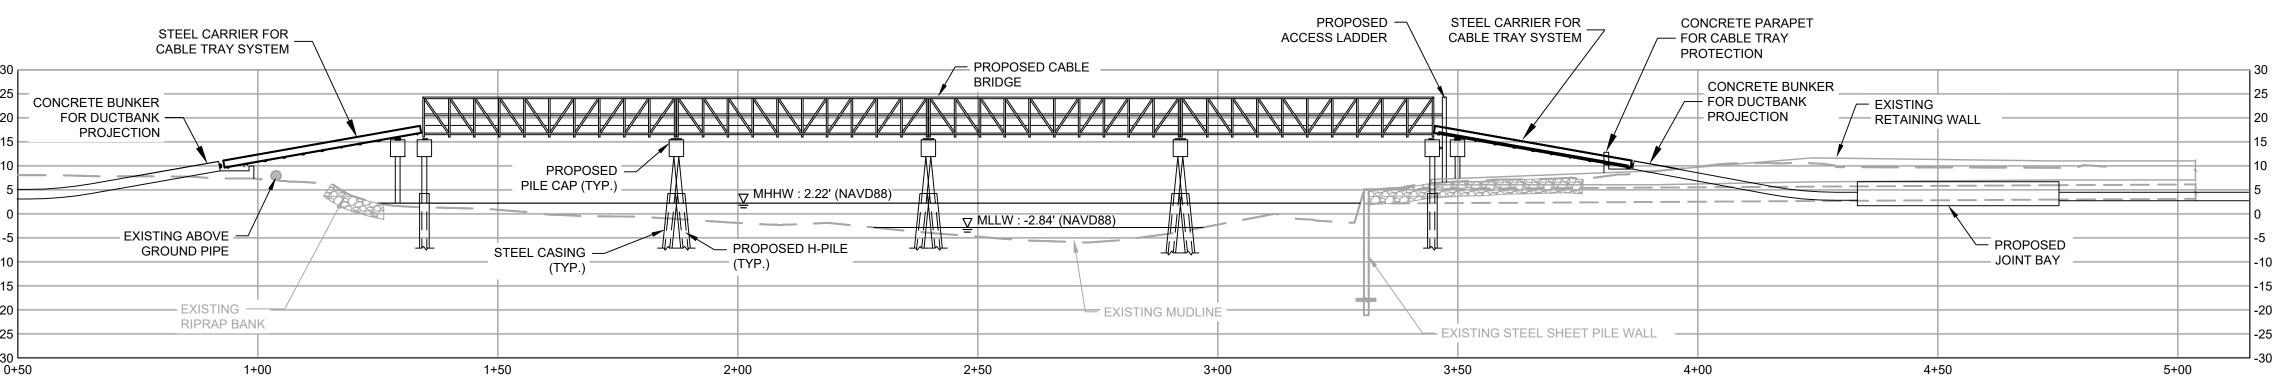
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CABLE BRIDGE CROSSING - BARNUMS CHANNEL **PLAN VIEW** SCALE: 1" = 20'





CABLE BRIDGE CROSSING - BARNUMS CHANNEL PROFILE VIEW SCALE: 1" = 20'

Ch'k'd App'd
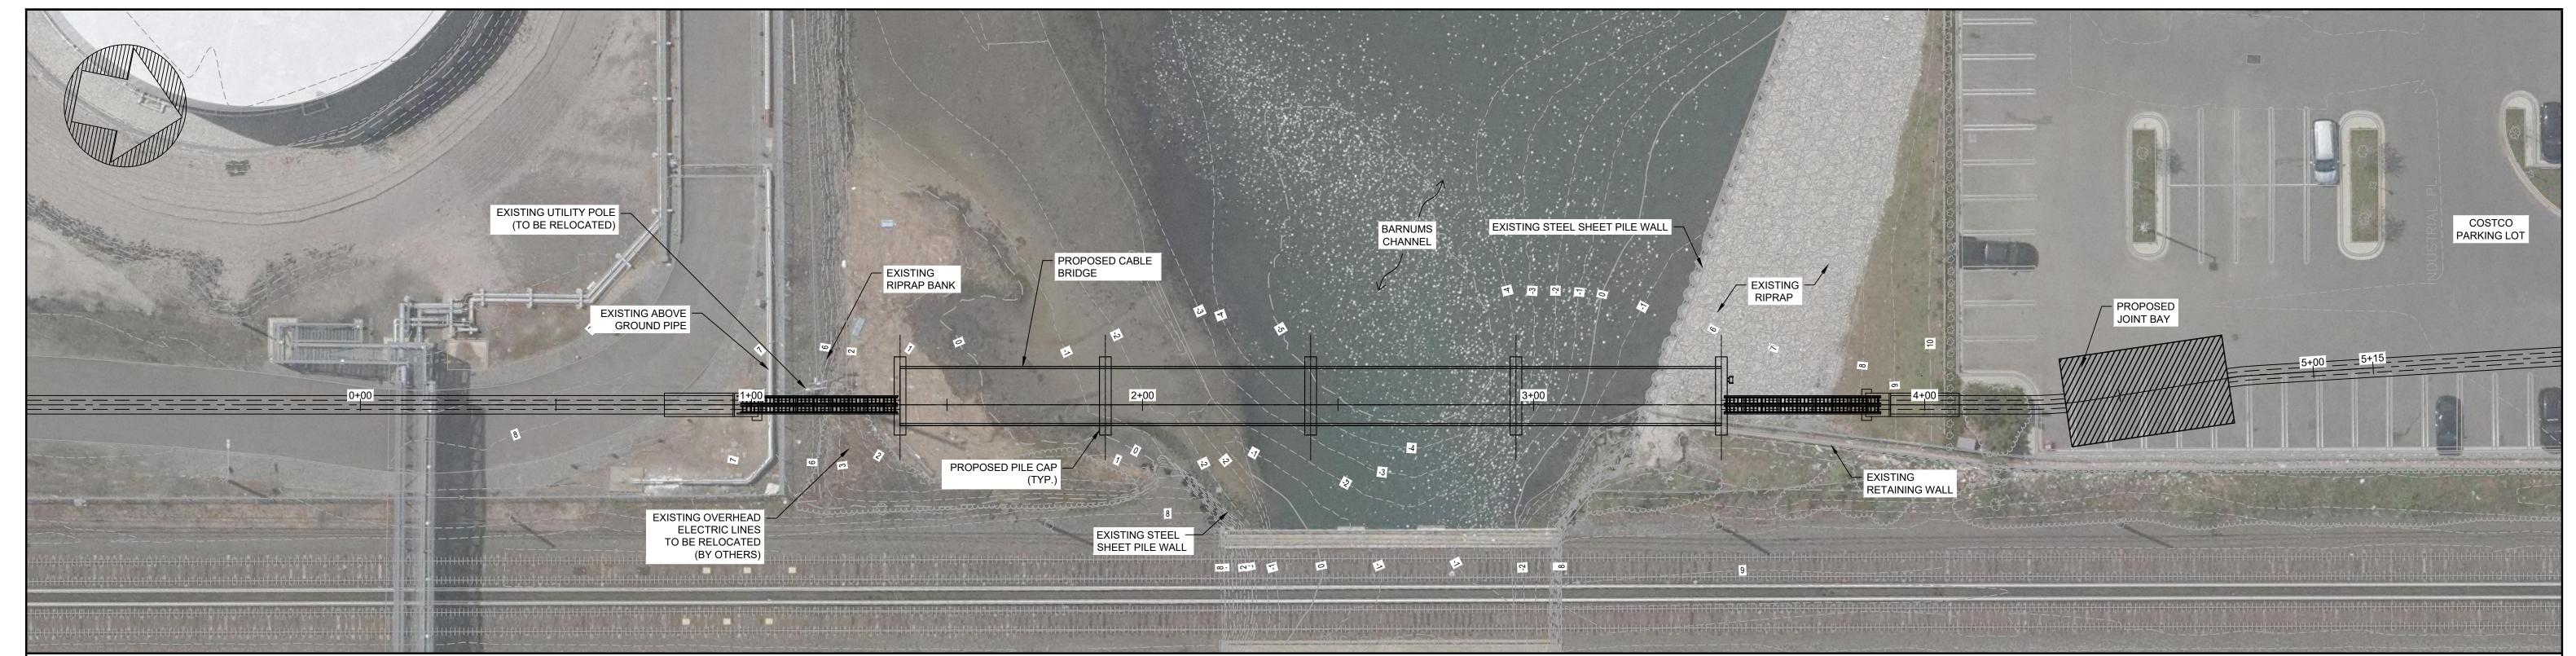
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Drawing Number BARNUMS CHANNEL CABLE BRIDGE								

1. LOCATION AND DEPTH OF ALL UTILITIES ARE TO BE FIELD VERIFIED.


8. CONVERSION FOR VERTICAL DATUM IS NAVD88 + 2.84' = MLLW. 9. DRAWING IS FOR PERMITTING PURPOSES ONLY, NOT FOR CONSTRUCTION.

2. PROPOSED CABLE ALIGNMENTS SHOWN MAY BE ADJUSTED DUE TO UNFORESEEN CONDITIONS. 3. MOTT MACDONALD HAS NOT CONDUCTED CIVIL SURVEYS WITHIN THE AREA SHOWN.


5. PROPERTY LINES SHOWN ON THIS MAP ARE TAX MAP GRADE AND NOT A RESULT OF A BOUNDARY SURVEY. BATHYMETRIC DATA WITHIN BARNUMS CHANNEL IS FROM PUBLIC SOURCES (NOAA).
 HORIZONTAL DATUM IS NAD83, NEW YORK STATE PLANE, LONG ISLAND US FOOT. VERTICAL DATUM IS NAVD1988.

10. BULKHEAD TIP ELEVATION IS FROM BULKHEAD REPAIR WORK FOR COSTCO OF OCEANSIDE PLAN SET, SHEET BW302.

4. THE SURVEYED CONTOURS (ONSHORE) AND IMAGERY SHOWN ARE FROM AN AERIAL FLIGHT FLOWN ON 04/23/2021 PROVIDED BY ROBINSON

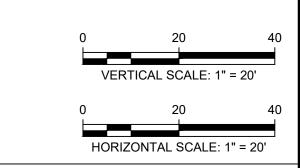

EMPIRE OFFSHORE WIND LLC. **EMPIRE WIND 2 PROJECT** BARNUMS CHANNEL CABLE BRIDGE PLAN AND PROFILE NASSAU COUNTY, NEW YORK ISSUED FOR ARTICLE VII APPLICATION

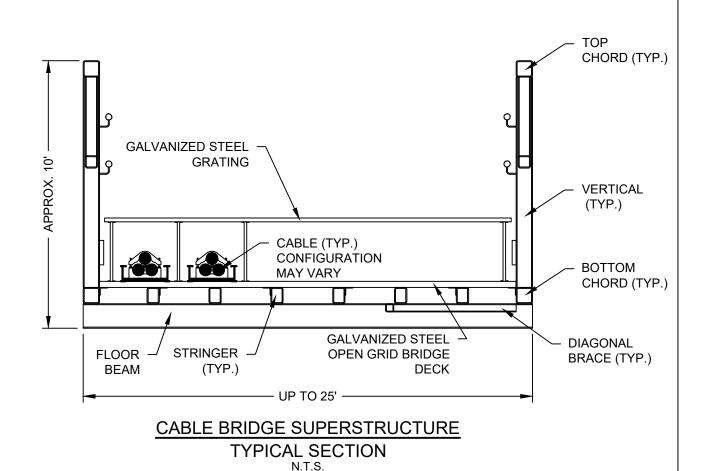

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## Title

EMPIRE OFFSHORE WIND LLC.
EMPIRE WIND 2 PROJECT
BARNUM CHANNEL CABLE BRIDGE
TYPICAL SECTION
ISSUED FOR ARTICLE VII APPLICATION

## M MOTT MACDONALD

Mott MacDonald NY Inc. 111 Wood Avenue South Iselin, NJ 08830-4112 Certificate of Authorization #: 0017019

Date	Drawn	Checked	Approved	Scale at ANSI A	Drawing Number	Status	Rev
04/07/2022	DOW	KEK	MDN	As Shown	BARNUM CHANNEL CABLE BRIDGE TYPICAL SECTION	PRE	В